
NOTE:

- 1. CONFIRM THE FOLLOWING WITH THE SALES REP.: - LOCATIONS AND HEIGHTS OF ALL ELECTRICAL OUTLETS AND NETWORK CABLE JACKS
- 2. GENERAL CONTRACTOR TO OUTFIT ALL NON-DENTAL SPACE WITH ELECTRICAL TO CONFORM WITH LOCAL BY-LAWS AND ONTARIO BUILDING CODE
- 3. PLEASE NOTE LEAD LINING WITHIN PARTITION WALLS. LEAD LINING REQUIRED AS PER THE MINISTRY OF HEALTH INSPECTION SERVICE. REFER TO APPROVED 'A-03 X-RAY RADIATION PLAN' TO FOLLOW.
- 4. PLUMBER AND ELECTRICIAN TO BE ON-SITE DURING INSTALLATION OF ALL DENTAL EQUIPMENT FOR FINAL CONNECTIONS.
- 5. ALL NETWORK CABLES TO BE CAT 6

SEE SALES REP FOR HEIGHT AND LOCATIONS OF ALL OUTLETS AND CONDUITS, AND LOCATION OF DATA SERVER, IMAGE SERVER AND HUB.

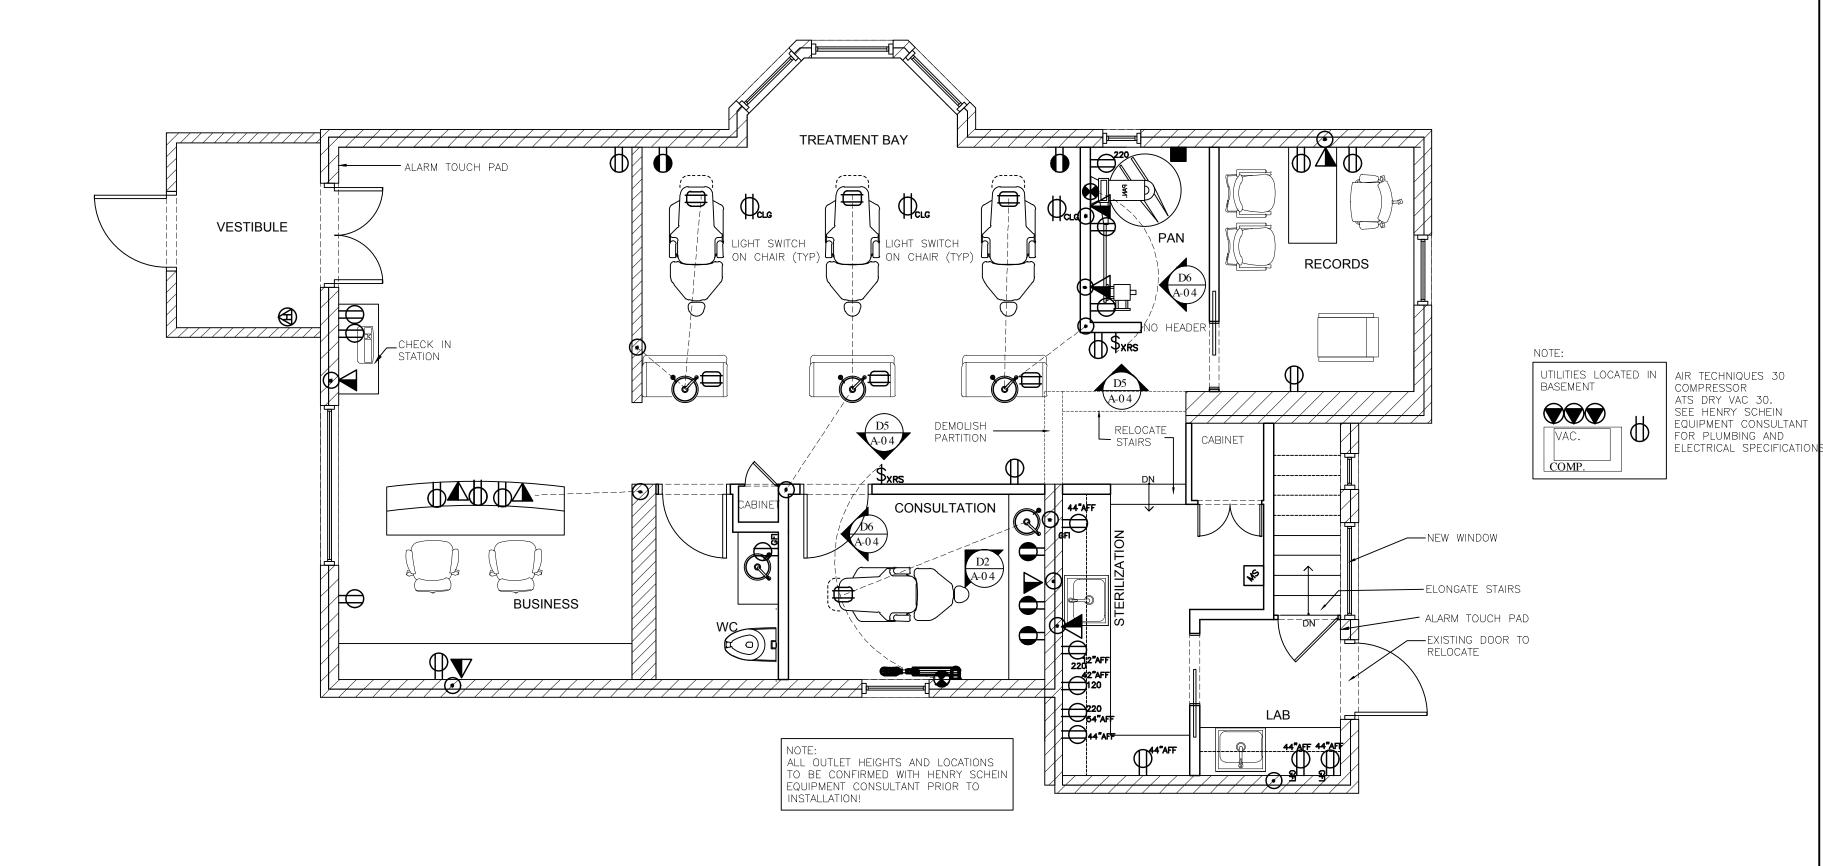


ELECTRICAL SPECIFICATIONS:

ALL SERVICES PENETRATING FLOOR.

- 1. ALL ELECTRICAL MUST CONFORM TO ONTARIO BUILDING CODES AND BASE BUILDING STANDARDS.
- 2. PROVIDE WATERPROOFING / FIRE PROOF SEALANT FOR
- 3. ALL WALL COVER PLATES ARE TO BE WHITE PLASTIC, UNLESS OTHERWISE AGREED UPON WITH CLIENT. WHERE TWO OR MORE OUTLETS OR SWITCHES OCCUR IN ONE LOCATION, A GANG SHALL BE USED.
- 4. THE ELECTRICAL CONTRACTOR IS RESPONSIBLE FOR THE FINAL CONNECTION OF ALL DENTAL EQUIPMENT AT TIME OF INSTALLATION. THE ELECTRICAL CONTRACTOR SHALL COORDINATE ALL CONNECTIONS WITH HENRY SCHEIN CANADA INC. INSTALLATION SUPERVISOR AND SALES REP.
- 5. THE ELECTRICAL CONTRACTOR IS RESPONSIBLE TO PRE-INSPACT THE SITE TO DETERMINE THE AVAILABILITY AND ELECTRICAL SUPPLY REQUIRED TO COMPLETE THIS PROJECT.
- 6. THE ELECTRICAL/GENERAL CONTRACTOR SHALL DETERMINE THE LOCATION AND INSTALL ALL EMERGENCY EXIT LIGHTS AND EMERGENCY LIGHT FIXTURES AS REQUIRED BY LOCAL CODES.
- 7. THE ELECTRICAL CONTRACTOR IS TO COORDINATE WITH PLUMBER FOR ELECTRICAL SUPPLY TO HOT WATER HEATER AND COLD WATER ELECTRIC SOLENOID. PROVIDE 110V COLD WATER ELEC. SOLENOID SHUTOFF VALVE.

PLEASE NOTE: ALL DIMENSIONS ARE BASED ON ORIGINAL BLUEPRINT PROVIDED TO THE HENRY SCHEIN CANADA PLANNING & DESIGN DEPARTMENT. AS-BUILT DIMENSIONS MUST BE JOB SITE VERIFIED BY HENRY SCHEIN CANADA INC. EQUIPMENT INSTALLATION SUPERVISOR.

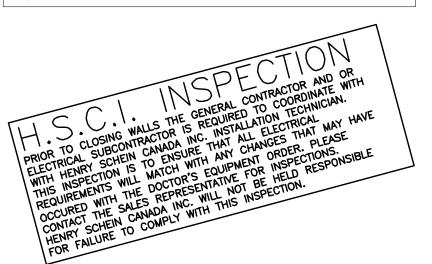

FINALS REVIEWED BY:

ELECTRICAL SCHEDULE:

DUPLEX RECEPTACLE, 115V, 15AMP STANDARD DUPLEX RECEPTACLE 12" AFF OR AS NOTED

(APPROXIMATELY 6 PER CIRCUIT) SINGLE CIRCUIT, DUPLEX RECEPTACLE SINGLE CIRCUIT

115V, 15AMP 12" AFF OR AS NOTED. HOSPITAL GRADE GFCI GROUND FAULT DUPLEX RECEPTACLE, NEMA 5-15R, 2P, 3W, 125VAC, 15AMP 12" AFF. OR AS NOTED. (APPROXIMATELY 6 PER CIRCUIT)

GROUND FAULT INSULATED DUPLEX RECEPTACLE, 115V, GFI 15AMP 12" AFF OR AS NOTED.

CEILING MOUNTED DUPLEX RECEPTACLE FOR T.V. MONITORS, GANGED W/ KNOCK-OUT BOX FOR TV CABLE CEILING PLATE.

DUPLEX RECEPTACLE ABOVE FINISHED CEILING WITHIN 6" OF CEILING MOUNTED DENTAL LIGHT LOCATION. HOSPITAL CLG GRADE GFCI GROUND FAULT, NEMA 5-15R, 2P, 3W, 125VAC,

FLOOR MOUNTED QUAD RECEPTACLE THROUGH FLOOR, FREE HANGING BY BX CABLE. HOSPITAL GRADE GFCI GROUND FAULT, NEMA 5-15R, 2P, 3W, 125VAC, 15AMP.

115V, 20AMP SINGLE CIRCUIT, HARDWIRED TO DENTAL EQUIPMENT.

DUPLEX RECEPTACLE. 220V SINGLE CIRCUIT 12" AFF OR AS NOTED.

220V, 20AMP 3 WIRE PLUS GROUND SINGLE CIRCUIT

CONNECTED TO STEP UP TRANSFORMER 7500 VA, HARDWIRED TO DENTAL EQUIPMENT. COMMUNICATIONS OUTLET, VOICE LINE SINGLE JACK 12"

AFF OR AS NOTED. COMMUNICATIONS OUTLET, **CAT 6** DATA LINE SINGLE

JACK 12" AFF OR AS NOTED. COMMUNICATIONS OUTLET, VOICE AND **CAT 6** DATA

DOUBLE JACK 12" AFF OR AS NOTED. INTRA ORAL CAMERA OUTLET, CONTRACTOR TO PROVIDE

3/4" CONDUIT FROM CEILING TO KNOCK-OUT BOX W/ COVER PLATE, 44" AFF OR AS NOTED (WIRE SUPPLIED BY OTHERS). MASTER ON-OFF SWITCHES, 52"AFF. WITH RED INDICATOR

LIGHTS TO DENTAL COMPRESSOR, DENTAL VACUUM AND MAIN WATER SOLENOID. COORDINATE WITH PLUMBER FOR LOCATION OF SOLENOID.

— 2" CONDUIT

REMOTE EXPOSURE SWITCH FOR DENTAL X-RAY, 52"AFF. PROVIDE CONDUIT WITH 4 STRAND WIRE TO X-RAY CONTROL BOX. SEE X-RAY SPECIFICATIONS.

POWER TO BE HARDWIRED TO LXCB X-RAY CONTROL BOX, SEE X-RAY SPECIFICATIONS.

X-RAY CONTROL BOX, 52"AFF. OR AS NOTED. PROVIDE 115V

DENTAL X-RAY. SEE X-RAY DETAILS AND SPECIFICATIONS (CONSULT TECHNICIAN).

2" DIA. EMPTY CONDUIT WITH PULL WIRE IN WALL FROM 4" X 4" BOX UP 12 1/2" A.F.F. UP TO CEILING SPACE.

VERIFY LOCATION OF CPU WITH HENRY SHEIN CANADA INC.

AUTOMATIC DOOR OPENER PUSH BUTTON

HEATER DIRECT CONNECTION SINGLE CIRCUIT

TWO TONE CHIME, MOUNTED 84" A.F.F.

DOOR TRIPPER CONNECTED TO CHIME

design, and has the qualifications and meets the requirements set out in the Ontario Building Code to be a designer.

QUALIFICATION INFORMATION

REGISTRATION INFORMATION

ELECTRICAL PLAN

PROJECT:

2011-008 DR. JINDAL

HENRY SCHEIN® *

DRAWN BY: SALES REP: EQUIP. SPEC.: KEN CRONEY

INSTALLER:


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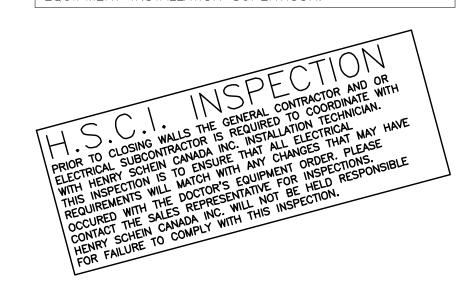
DWG. SCALE: 1/4" = 1'-0" START DATE: APRIL 18, 201 USABLE AREA: 1,020 S.F. FILE: JINDAL-2011-008





FINALS REVIEWED BY:

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LIGHTING SPECIFICATIONS:
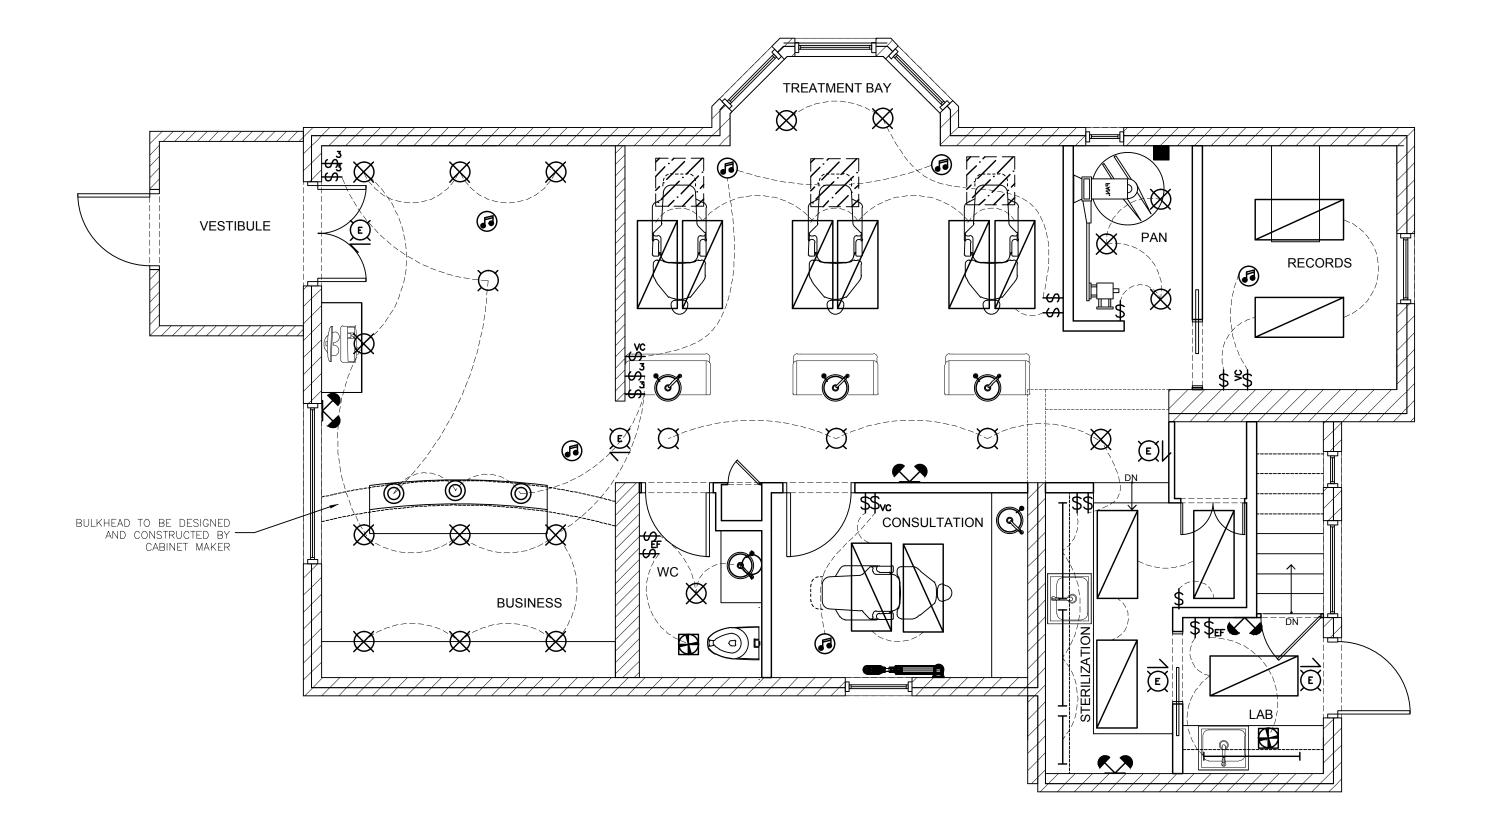
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3. THE ELECTRICIAN TO COORDINATE WITH GENERAL CONTRACTOR FOR LOCATION OF EMERGENCY LIGHT FIXTURES AND EMERGENCY EXIT LIGHTS AS REQUIRED BY LOCAL CODES.

LIGHTING SCHEDULE:




LIGHT FIXTURES, 2'X4' RECESSED FLUORESCENT, 4 LAMP WITH DIFFUSER




LIGHT FIXTURES, 2'X2' RECESSED FLUORESCENT, 2 LAMP WITH PARABOLIC





CORRIDOR LIGHT FIXTURES, 1'X4'
RECESSED FLUORESCENT, 2 LAMP WITH

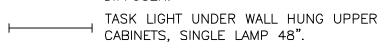


TRACK LIGHTS SURFACE MOUNTED, LAMPS AS NOTED.

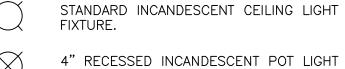


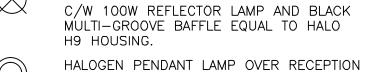


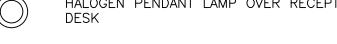

WSC WALL SCOTTON AS NOTED. WALL SCONCE, VERIFY WITH CLIENT, OR

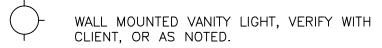

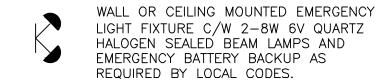

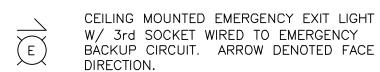

RECESSED CEILING MOUNTED MUSIC SPEAKER.

CENTRAL MUSIC SOURCE, TERMINATE LOW VOLTAGE WIRES IN KNOCK OUT BOX WITH CABLE WALL COVER PLATE.


WALL MOUNTED VOLUME CONTROL @ 52" AFF OR AS NOTED.


SINGLE POLE LIGHT SWITCH @ 52" AFF OR AS NOTED.

THREE-WAY LIGHT SWITCH @ 52" AFF OR AS NOTED.

DIMMER SWITCH @ 52" AFF OR AS NOTED.

EXHAUST FAN SWITCH @ 52" AFF OR AS

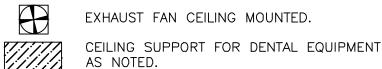

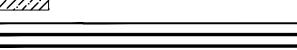

The undersigned has reviewed and takes responsibility for this design, and has the qualifications and meets the requirements set out in the Ontario Building Code to be a designer. QUALIFICATION INFORMATION

REFLECTED CEILING PLAN

PROJECT:

2011-008 DR. JINDAL

PROJECT NORTH

DRAWING NUMBER:

HENRY SCHEIN® 221 JACOB KEFFER PARKWAY - CONCORD - ONTARIO - L4K 5T9

T: 905-832-9101 F: 905-417-8675

DRAWN BY: SALES REP: EQUIP. SPEC.: KEN CRONEY INSTALLER:

REVISION LOG: REV. # DATE REV.# DATE

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DWG. SCALE: 1/4" = 1'-0" START DATE: APRIL 18, 201 USABLE AREA: 1,020 S.F. FILE: JINDAL-2011-008

- 1. ALL PLUMBING FIXTURES TO BE WHITE AND FREE FOR BLEMISHES.
- 2. ALL EXPOSED PIPING, VALVES, TRAPS, FITTINGS, ETC., SHALL BE HEAVILY CHROME PLATED BRASS. 3. INCLUDE ALL LABOUR, EQUIPMENT, TOOLS AND
- OTHER INCIDENTALS NECESSARY AND REQUIRED FOR THE COMPLETE INSTALLATION, USE ONLY NEW MATERIALS AND EQUIPMENT. 4. ALL WORK SHALL BE IN ACCORDANCE WITH THE LATEST EDITIONS OF LOCAL CODES AND STANDARDS
- AND WITH THE APPROVAL OF THE AUTHORITIES HAVING JURISDICATION. CONTRACTOR SHALL GIVE ALL NECESSARY NOTICES
- DBTAIN ALL REQUIRED PERMITS AND PAY FEES. CONTRACTOR SHALL INSPECT THE PROJECT PRIOR TO TENDER TO REALIZE THE SCOPE OF WORK INVOLED AND TO FAMILIARIZE YOURSELF WITH THE SITE CONITIONS, FAILURE TO DO SO WILL NOT RELIEVE THE CONTRACTOR OF RESPONSIBILITY IN THIS REGARD.
- PLUMBER TO SUPPLY AND INSTALL ALL NECESSARY VALVES AND FITTINGS FOR ALL DENTAL EQUIPMENT SUPPLIED AND INSTALLED BY HENRY SCHEIN

	SCHEDULE
v	1 1/2" IPS, PVC, SCH. 40 VACUUM LINE, SLOPE 1" PER 20' TOWARD PUMP, USE 45° BENDS.
A	1/2" ID TYPE 'L' COPPER, COMPRESSED AIR LINE
⊗	VAC DUTLET
(A)	AIR DUTLET

PROVIDE VENT LINES AS PRE LOCAL CODES PROVIDE CLEAN DUTS ON VACUUM LINES AND SANITARY DRAIN LINES

- 1. GENERAL CONTRACTOR TO LOCATE AND TIE IN ALL PLUMBING
- 2. SALES REP. TO SPOT LOCATION OF SERVICES IN OPERATORIES.
- 3. ALL HOT AND COLD WATER LINES TO BE INSULATED.
- 4. PLUMBER AND ELECTRICIAN TO BE ON-SITE DURING INSTALLATION OF ALL DENTAL EQUIPMENT FOR FINAL CONNECTIONS.

GENERAL CONTRACTOR TO LOCATE AND TIE IN ALL PLUMBING SERVICES.

USE MANUFACTURES' SPECS AND TEMPLATES FOR ALL EQUIPMENT

NOTES


SALES REP. TO SUPERVISE JOB

SALES REP. TO CONFIRM AND SPOT LOCATION OF SERVICES IN OR.5

ALL HOT AND COLD WATER LINES TO BE INSULATED

PLUMBER TO BE ON SITE DURING

INSTALLATION OF DENTAL EQUIPMENT FOR FINAL CONNECTIONS

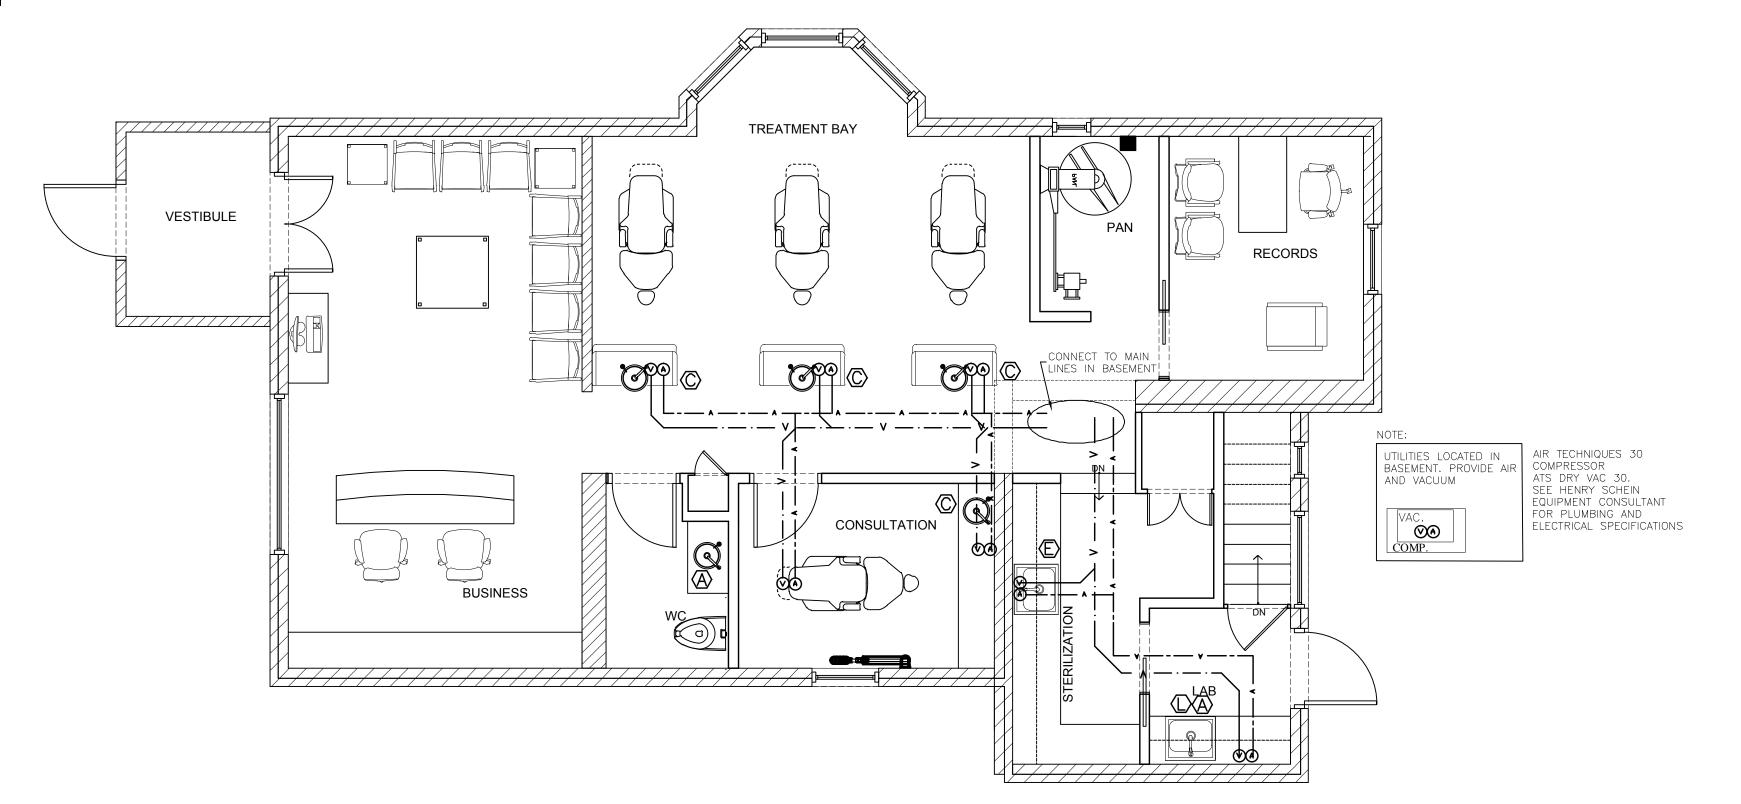

PLUMBING SPECIFICATIONS:

1. ALL PLUMBING MUST CONFORM TO THE ONTARIO BUILDING CODE AND BASE BUILDING STANDARDS.

2. ALL SERVICES PENETRATING THE FLOORS MUST BE SEALED TO ENSURE WATER PROOFINGAND A 1 HOUR FIRE-RATING.


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4. THE PLUMBING CONTRACTOR TO PROVIDE 1/2" HOT & COLD WATER SUPPLY AND 1 1/2" TRAPPED AND VENTED DRAIN TO ALL DOMESTIC SINKS.

5. ALL 1/2" AIR, 1/2" WATER OTHER THAN SINK CONNECTION MUST BE FINISHED WITH MANUAL SHUTOFF VALVES RA 19 3/8" COMPRESSION FITTINGS.

6. THE PLUMBING CONTRACTOR MUST SUPPLY AND INSTALL BACK FLOW PREVENTION VALVES AND/OR R.P. VALVES AS PER PLUMBING CODES AND REGULATIONS FOR DENTAL EQUIPMENT. VALVES MUST BE ACCESSIBLE FOR ROUTINE MAINTENANCE.

ALL DIMENSIONS ARE BASED ON ORIGINAL BLUEPRINT PROVIDED TO THE HENRY SCHEIN CANADA PLANNING & DESIGN DEPARTMENT. AS-BUILT DIMENSIONS MUST BE JOB SITE VERIFIED BY HENRY SCHEIN CANADA INC. EQUIPMENT INSTALLATION SUPERVISOR.

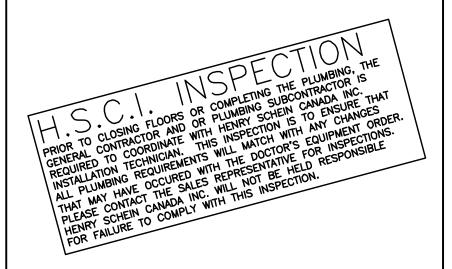

PLUMBING SCHEDULE:

- 1/2" HOT AND 3/4" COLD WATER WITH 11/2" TRAPPED AND VENTED WASTE LINE TO SINK.
- 1/2" HOT AND 3/4" COLD WATER, SECONDARY 1/2" COLD WATER, 1/2" AIR WITH $1\frac{1}{2}$ " TRAPPED AND VENTED WASTE LINE TO SINK. PLUMBER TO INSTALL BACK FLOW PREVENTION VALVES BEFORE MANUAL SHUT OFF VALVE IF DENTAL UNIT IS NOT OUTFITTED WITH SELF CONTAINED CLEAN WATER SYSTEM.
- 1/2" HOT AND 3/4" COLD WATER, SECONDARY 1/2" COLD WATER, ½" AIR, 1 1/2" VACUUM LINE TERMINATE WITH 1/2" AND 1 1/2" TRAPPED AND VENTED WASTE LINE. PLUMBER TO INSTALL BACK FLOW PREVENTION VALVES BEFORE MANUAL SHUT OFF IF DENTAL UNIT IS NOT OUTFITTED WITH SELF CONTAINED CLEAN WATER SYSTEM.
- 3/4" COLD WATER, 1/2" AIR, 1 1/2" VACUUM LINE TERMINATE WITH 1/2" AND 1 1/4" WET VENTED WASTE RISERS. ALL UTILITIES THROUGH FLOOR TO MOUNTED DENTAL UTILITY CENTER. PLUMBER TO INSTALL BACK FLOW PREVENTION VALVES BEFORE MANUAL SHUT OFF IF DENTAL UNIT IS NOT OUTFITTED WITH SELF CONTAINED CLEAN WATER SYSTEM.
- 1/2" HOT AND 3/4" COLD WATER, SECONDARY 1/2" COLD WATER, 1/2" AIR, 1 1/2" VACUUM LINE TERMINATE WITH 1/2" AND 11/2" TRAPPED AND VENTED WASTE.
- 3/4" COLD WATER, 1/2" AIR AND 1 1/2" VACUUM LINE TERMINATE WITH 1/2" RISERS TO CABINET UTILITY SECTION AT FLOOR LEVEL. PLUMBER TO INSTALL BACK FLOW PREVENTION VALVES BEFORE MANUAL SHUT OFF VALVE IF DENTAL UNIT IS NOT OUTFITTED WITH SELF CONTAINED CLEAN WATER SYSTEM.
- 3/4" COLD WATER TO 1/2" GARDEN HOSE VALVE UP 16" AND 11/2" NON-CORROSIVE OPEN CUP TYPE DRAIN UP 20". NOTE: FOR SILVER RECOVERY AND DILUTION TANK DRAIN TO BE 12" A.F.F.
- 3/4" MAIN INCOMING COLD WATER WITH BACK FLOW PREVENTION VALVE PRESSURE VACUUM BREAKER TO 3/4" SHUTOFF ELECTRIC SOLENOID AND WATER FILTER AVAILABLE FROM HENRY SCHEIN CANADA INC. TO BE INSTALLED BY PLUMBER. LOCATION TO BE DETERMINED BY PLUMBER ON SITE.
- 1/2" SECONDARY COLD WATER AND VENTED
- DENTAL VACUUM PUMP (SUPPLIED) TERMINATE VACUUM LINE. PROVIDE 3/4" COLD WATER TO 1/2" BRASS GATE VALVE. EXHAUST TO 2" TRAPPED AND VENTED DRAIN.
- DENTAL COMPRESSOR (SUPPLED) TERMINATE 1/2" COPPER AIR LINE AT COMPRESSOR.
- PLASTER IRAP 10 BE INSTALLED STATE AVAILABLE FROM HENRY SCHEIN CANADA INC. PLASTER TRAP TO BE INSTALLED BY PLUMBER,
- M AMALGAM SEPARATOR

FINALS REVIEWED BY:

The undersigned has reviewed and takes responsibility for this design, and has the qualifications and meets the requirements set out in the Ontario Building Code to be a designer. QUALIFICATION INFORMATION

PLUMBING PLAN AIR & VACUUM LINES

PROJECT:

2011-008 DR. JINDAL

DRAWING NUMBER:

MENRY SCHEIN® *

DRAWN BY: SALES REP: EQUIP. SPEC.: INSTALLER:

REVISION LOG: REV.# DATE REV.# DATE

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2. SALES REP. TO SPOT LOCATION OF SERVICES IN OPERATORIES.

3. ALL HOT AND COLD WATER LINES TO BE INSULATED.

4 . PLUMBER AND ELECTRICIAN TO BE ON-SITE DURING INSTALLATION OF ALL DENTAL EQUIPMENT FOR FINAL CONNECTIONS.

GENERAL CONTRACTOR TO LOCATE AND TIE IN ALL PLUMBING SERVICES.

SCHEDULE ——— c — 3/4" ID TYPE 'L' COPPER, COLD WATER LINE ---- H = 1/2" ID TYPE 'L' COPPER, HOT WATER LINE SANITARY DRAIN LINE SANITARY DRAIN COLD WATER HOT WATER FLOOR DRAIN

> PROVIDE VENT LINES AS PRE LOCAL CODES PROVIDE CLEAN OUTS ON VACUUM LINES AND SANITARY DRAIN LINES

> > UTILITIES LOCATED IN BASEMENT. PROVIDE COLD

PROVIDE FLOOR DRAIN IN UTILITY ROOM

WATER AND DRAIN.

COMP.

NOTES

USE MANUFACTURES' SPECS AND TEMPLATES FOR ALL EQUIPMENT

SALES REP. TO SUPERVISE JOB


TO BE INSULATED

SALES REP. TO CONFIRM AND SPOT LOCATION OF SERVICES IN OR.5

ALL HOT AND COLD WATER LINES

PLUMBER TO BE ON SITE DURING INSTALLATION OF DENTAL EQUIPMENT FOR FINAL CONNECTIONS

- 1. ALL PLUMBING FIXTURES TO BE WHITE AND
- FREE FOR BLEMISHES. 2. ALL EXPOSED PIPING, VALVES, TRAPS, FITTINGS, ETC., SHALL BE HEAVILY CHROME PLATED BRASS.
- 3. INCLUDE ALL LABOUR, EQUIPMENT, TOOLS AND OTHER INCIDENTALS NECESSARY AND REQUIRED FOR THE COMPLETE INSTALLATION, USE ONLY NEW MATERIALS AND EQUIPMENT
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PLUMBING SPECIFICATIONS:

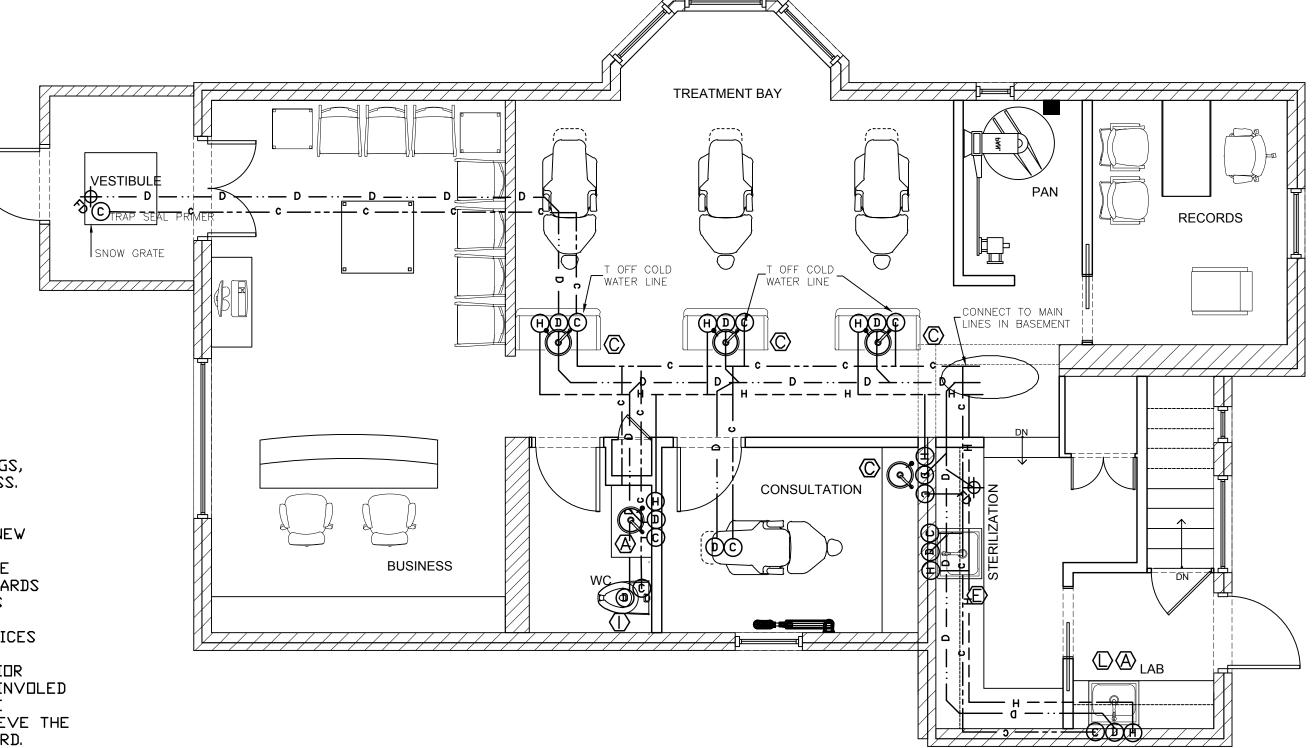1. ALL PLUMBING MUST CONFORM TO THE ONTARIO BUILDING CODE AND BASE BUILDING STANDARDS.

2. ALL SERVICES PENETRATING THE FLOORS MUST BE SEALED TO ENSURE WATER PROOFINGAND A 1 HOUR FIRE-RATING.


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4. THE PLUMBING CONTRACTOR TO PROVIDE 1/2" HOT & COLD WATER SUPPLY AND 1 1/2" TRAPPED AND VENTED DRAIN TO ALL DOMESTIC SINKS.

5. ALL 1/2" AIR, 1/2" WATER OTHER THAN SINK CONNECTION MUST BE FINISHED WITH MANUAL SHUTOFF VALVES RA 19 3/8" COMPRESSION FITTINGS.

6. THE PLUMBING CONTRACTOR MUST SUPPLY AND INSTALL BACK FLOW PREVENTION VALVES AND/OR R.P. VALVES AS PER PLUMBING CODES AND REGULATIONS FOR DENTAL EQUIPMENT. VALVES MUST BE ACCESSIBLE FOR ROUTINE MAINTENANCE.

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PLUMBING SCHEDULE:

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- 1/2" HOT AND 3/4" COLD WATER, SECONDARY 1/2" COLD WATER, ½" AIR, 1 1/2" VACUUM LINE TERMINATE WITH 1/2" AND 1 1/2" TRAPPED AND VENTED WASTE LINE. PLUMBER TO INSTALL BACK FLOW PREVENTION VALVES BEFORE MANUAL SHUT OFF IF DENTAL UNIT IS NOT OUTFITTED WITH SELF CONTAINED CLEAN WATER SYSTEM.
- 3/4" COLD WATER, 1/2" AIR, 1 1/2" VACUUM LINE TERMINATE WITH 1/2" AND 1 1/4" WET VENTED WASTE RISERS. ALL UTILITIES THROUGH FLOOR TO MOUNTED DENTAL UTILITY CENTER. PLUMBER TO INSTALL BACK FLOW PREVENTION VALVES BEFORE MANUAL SHUT OFF IF DENTAL UNIT IS NOT OUTFITTED WITH SELF CONTAINED CLEAN WATER SYSTEM.
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- 3/4" COLD WATER, 1/2" AIR AND 1 1/2" VACUUM LINE TERMINATE WITH 1/2" RISERS TO CABINET UTILITY SECTION AT FLOOR LEVEL. PLUMBER TO INSTALL BACK FLOW PREVENTION VALVES BEFORE MANUAL SHUT OFF VALVE IF DENTAL UNIT IS NOT OUTFITTED WITH SELF CONTAINED CLEAN WATER SYSTEM.
- 3/4" COLD WATER TO 1/2" GARDEN HOSE VALVE UP 16" AND 11/2" NON-CORROSIVE OPEN CUP TYPE DRAIN UP 20". NOTE: FOR SILVER RECOVERY AND DILUTION TANK DRAIN TO BE 12" A.F.F.
- 3/4" MAIN INCOMING COLD WATER WITH BACK FLOW PREVENTION VALVE PRESSURE VACUUM BREAKER TO 3/4" SHUTOFF ELECTRIC SOLENOID AND WATER FILTER AVAILABLE FROM HENRY SCHEIN CANADA INC. TO BE INSTALLED BY PLUMBER. LOCATION TO BE DETERMINED BY PLUMBER ON SITE.
- 1/2" SECONDARY COLD WATER AND VENTED
- DENTAL VACUUM PUMP (SUPPLIED) TERMINATE VACUUM LINE. PROVIDE 3/4" COLD WATER TO 1/2" BRASS GATE VALVE. EXHAUST TO 2" TRAPPED AND VENTED DRAIN.
- DENTAL COMPRESSOR (SUPPLED) TERMINATE 1/2" COPPER AIR LINE AT COMPRESSOR.
- PLASTER TRAP TO BE INSTALLED BY PLUMBER. AVAILABLE FROM HENRY SCHEIN CANADA INC.
- AMALGAM SEPARATOR

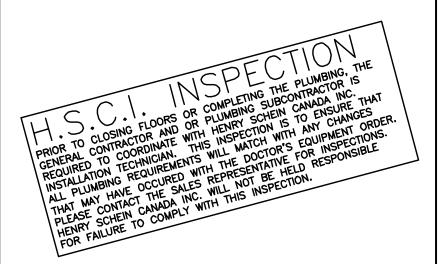FINALS REVIEWED BY:	
FSC:	
ESS:	

design, and has the qualifications and meets the requirements set out in the Ontario Building Code to be a designer. QUALIFICATION INFORMATION

PLUMBING PLAN HOT/COLD & DRAIN LINES

PROJECT:

2011-008

HENRY SCHEIN® *

DRAWN BY: SALES REP: EQUIP. SPEC.: INSTALLER:

REVISION LOG: REV. # DATE BY REV.# DATE 9 ARE SUBJECT TO JOB SITE VERIFICATION. 10

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DWG. SCALE: 1/4" = 1'-0" START DATE: APRIL 18, 201 USABLE AREA: 1,020 S.F. FILE: JINDAL-2011-008

PROJECT NORTH

DRAWING NUMBER: